
NOTES


- CONDUITS SHALL BE BURIED BELOW FROST LINE AND IN COMPLIANCE WITH LOCAL AND NATIONAL CODE REQUIREMENTS.
- 2. REFER TO CONDUIT AND WIRE SCHEDULE ON E-3 FOR CONDUIT AND WIRE REQUIREMENTS.
- INSTALL DOTTIE DUCT SEAL COMPOUND PC 6130 (CAT NO. LHD1) (TYP FOR ALL CONDUITS FOR CHARGER CABINETS AND DISPENSERS).
- 4. REFER TO SHEET E-2 FOR CONDUIT STUB LOCATION.

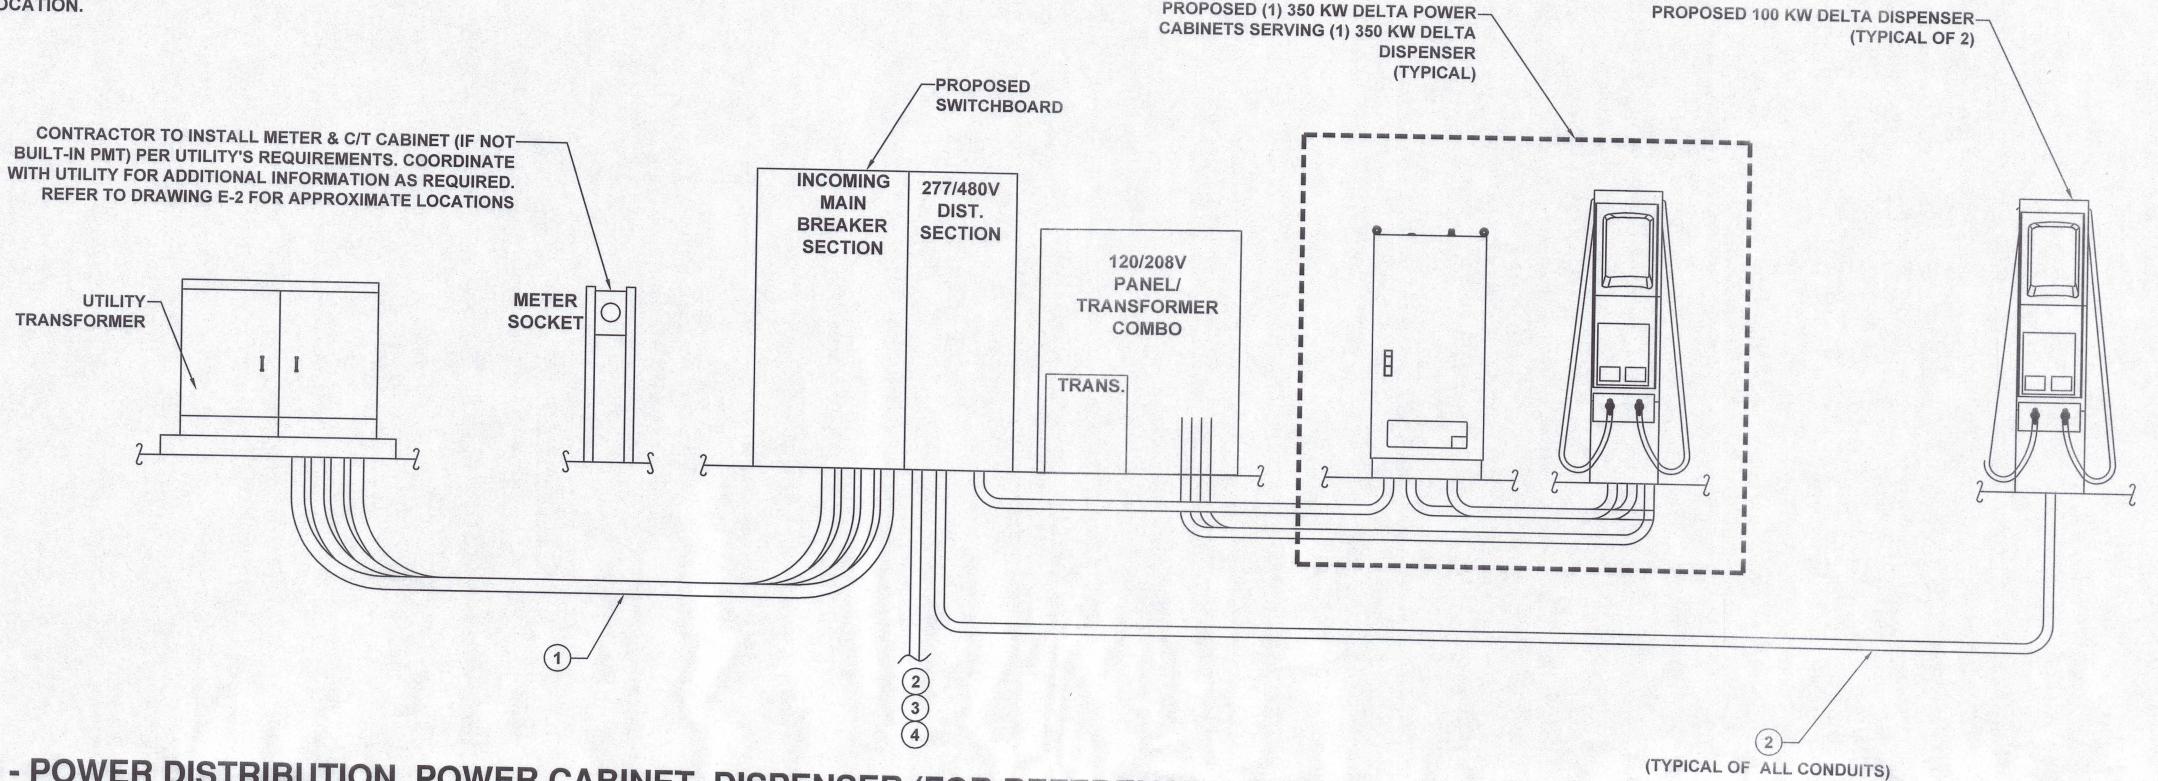

PROPOSED (1) 350 KW DELTA POWER-

CONDUIT ELEVATION - POWER DISTRIBUTION, POWER CABINET, DISPENSER (FOR REFERENCE ONLY) E-4 SCALE: N.T.S.


PENDING UTILITY DESIGN

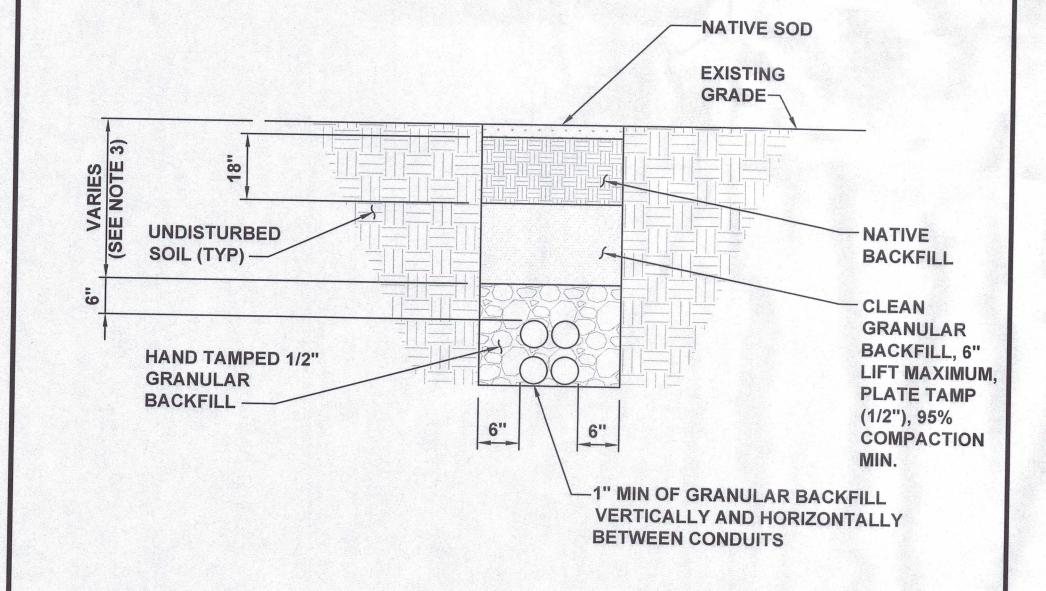

NOTES

- 1. ANY EXCAVATION LEFT OPEN NEEDS TO BE FENCED, BARRICADED, OR TRENCH PLATED TO INSURE THE SAFETY OF THE GENERAL PUBLIC.
- 2. ANY PAVEMENT DAMAGE DURING CONSTRUCTION SHALL BE REPAIRED OR REPLACED BY THE CONTRACTOR TO PRE CONSTRUCTION CONDITIONS OR BETTER.
- 3. TRENCH DEPTHS ARE REQUIRED TO BE 2'-0" MIN. OR 6" BELOW FROST LINE PER LOCAL JURISDICTION REQUIREMENTS.
- 4. EXACT NUMBER OF CONDUITS SHALL BE DETERMINED BY SHEET E-1 & E-2, EXACT CONDUIT PLACEMENT IN TRENCH SHALL BE DETERMINED BY THE CONTRACTOR IN THE FIELD BASED ON PHYSICAL MEASUREMENTS AND JURISDICTIONAL REQUIREMENTS.

TYPICAL NON-UTILITY CONDUIT UNDER SOIL TRENCH E-4 SCALE: N.T.S.

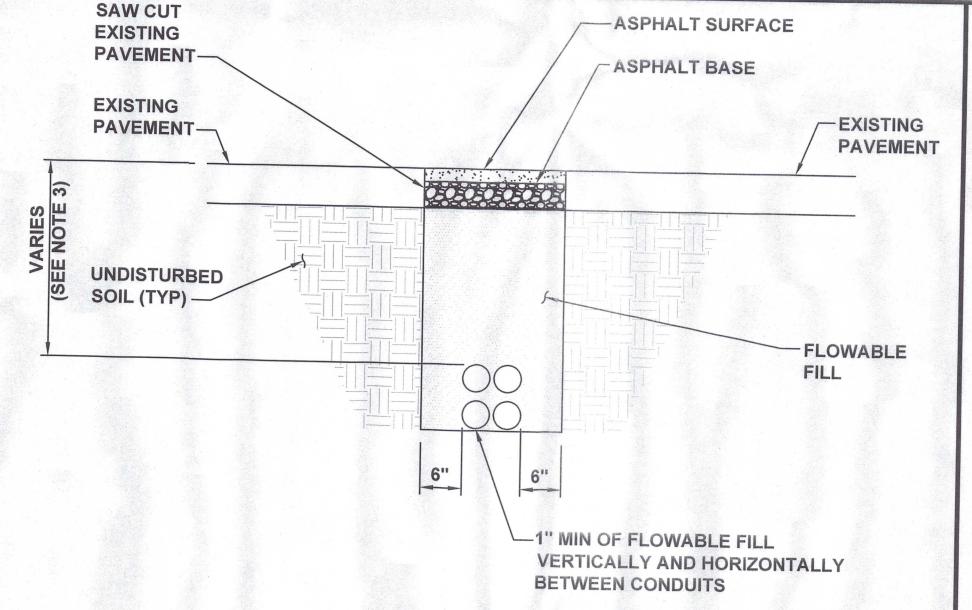

NOTES

- 1. ASPHALT SHALL COMPLY WITH STANDARD DOT OR LOCAL JURISDICTION SPEC. FOR HMA SURFACE COURSE.
- 2. ANY EXCAVATION LEFT OPEN NEEDS TO BE FENCED, BARRICADED, OR TRENCH PLATED TO INSURE THE SAFETY OF THE GENERAL PUBLIC.
- 3. TRENCH DEPTHS ARE REQUIRED TO BE 2'-0" MIN. OR 6" BELOW FROST LINE PER LOCAL JURISDICTION REQUIREMENTS.
- 4. ANY PAVEMENT DAMAGE DURING CONSTRUCTION SHALL BE REPAIRED OR REPLACED BY THE CONTRACTOR TO PRE CONSTRUCTION CONDITIONS OR BETTER.
- 5. EXACT NUMBER OF CONDUITS SHALL BE DETERMINED BY SHEET E-1 & E-2, EXACT CONDUIT PLACEMENT IN TRENCH SHALL BE DETERMINED BY THE CONTRACTOR IN THE FIELD BASED ON PHYSICAL MEASUREMENTS AND JURISDICTIONAL REQUIREMENTS.

TYPICAL NON-UTILITY CONDUIT UNDER ASPHALT TRENCH E-4 SCALE: N.T.S.



FAST CHARGING

EVgo SERVICES, LLC 11835 W OLYMPIC BLVD STE 900 E LOS ANGELES, CA 90064





WAWA #0157 NORTH WALES

593 DEKALB PIKE. -EV

NORTH WALES, PA 19454

SHEET DESCRIPTION: **ELECTRICAL DETAILS**



Project #: P17773 Drawn by: KC

Date(s): 07/25/2022 2022.07.25 - DD100 PRELIMINARY DESIGN 2022.08.08 - ISSUED FOR PERMIT